L2

L3

L4

L5

L6

L7

S 28'13'25" W

N 40°29'33" W

N 33'2'03" W

N 47'37'03" W

N 40'29'33" W

N 49°30'27" E

S 40'29'33" E

63.55

85.90'

96.01


96.01'

73.94'

232.64

433.34'

## **VICINITY MAP**

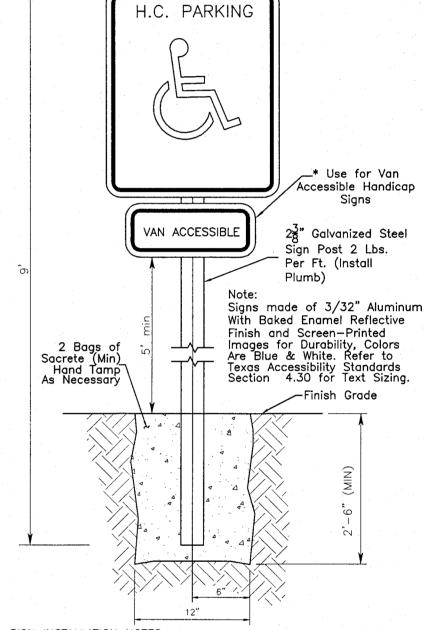

SIGN INSTALLATION NOTES:

1. All signs shall be posted on 8-foot-long, 2-3/8" outside diameter Galvanized Steel Pipe Signposts that weigh two (2) pounds per linear foot. These signposts shall be placed a minimum of 2.5 to 3.0 feet into the ground. A hole at least one—foot in diameter shall be dug or drilled a minimum of three (3) feet in depth. The signpost shall be placed vertically plumb in the center of the hole and secured with a minimum of two (2) sacks of sackcrete. The concrete mix shall be hand tamped as necessary.

2. The signs shall be installed so that the bottom of each sign shall be at least four (4) feet above the ground at the base of the signpost or above an adjacent travelway. All signposts shall be installed 24 inches from the travelway. The hardware used to attach the signs to the signposts shall be the same as that currently used by the city.

VAN ACCESSIBLE HANDICAP

4. Signs shall be positioned facing perpendicular to the parking stall

SIGN INSTALLATION DETAIL

## PER THE PLAT **FIRE LANE**

ONLY

firelanes on plans shall be painted red with 4" (four inch) white lettering stating "FIRE LANE-NO PARKING-TOW AWAY ZONE" Wording may not be spaced for than fifteen (15) feet apart. In addition to the curbs being striped, a fire lane sign 12" wide and 18" in height (as seen hereon) shall be DESIGNATED mounted at each entrance.\* **PARKING** 

\* 8" (eight inch) high red stripe and 4" (four inch) white lettering may be striped on the surface of the pavement behind parking stalls in lieu of signage.

All curbs and curb ends designated as

FIRE LANE NO PARKING TOW AWAY ZONE \*FIRE LN\* STRIPING

18" x 12" See Ordinance for additional Information & STRIPES ON BRIGHT

BLUE BACKGROUND) 24" DIAMETER 3'-8" HC SYMBOL DETAIL


FILENAME: HC-STRIPING.dwg PLOTTED: 30 May 2008 - 9:36 am

HANDICAPPED PARKING

IDENTIFICATION LOGO TO

BE PAINTED ON PAVING

(WHITE LETTERS SYMBOLS

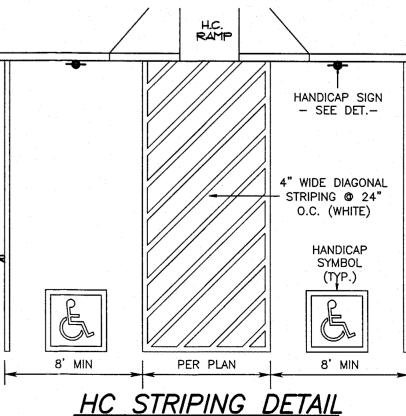

the City of Bryan City Engineer.

contractor shall be financially responsible for the engineer's time spent reviewing changes and redesigning based on contractors requests. 4. Trench Safety Requirements shall be in accordance with O.S.H.A. Standard 29 CFR Part 1926 Subpart P. TRENCHING AND BACKFILLING: All trenching and backfilling shall conform to the specifications set out herein. Testing shall be provided by a certified laboratory, at the Owner's expense, to verify these standards. Any retesting due to substandard work shall be at the expense of the Contractor. Structural areas shall include all sidewalks and shall extend 5' beyond the curb lines of all streets, alleys and parking areas. 6. It is the responsibility of the contractor to comply with all State and Federal Regulations regarding construction activities near energized overhead power lines. Additionally, the contractor shall coordinate all proposed work and procedures with BTU.

7. All materials & labor not identified as a Separate Bid Item shall be considered subsidiary to the item in which it is used. All materials and equipment shall be both furnished and installed unless otherwise noted.

8. The Contractor must provide construction staking from the information provide on these plans. 9. All soil exposed by construction shall receive cellulose fibermulch seeding.

10. Trenches may be left open overnight if properly barricaded. 11. Adjustment of Water Meters, Valves, Manholes, Irrigation Systems, and any other Public or Private Utility, etc. are not separate pay items. The Price of the adjustment shall be subsidiary to the construction of Sewer Line, Force Main, etc. 12. The contractor shall coordinate with Suddenlink Communications, BTU, Atmos Energy, and Verizon to adjust the location of existing

13. The contractor is responsible for traffic control. This is not a separate pay item.

14. No spoil areas are available on this site. 15. All signage will be permitted separately.

16. The Contractor shall be responsible for the containment and proper disposal of all liquid and solid waste associated with this project. The contractor shall use all means necessary to prevent the occurrence of windblown litter from the project site. 17. The Contractor shall assure that inspection of all work is completed by the Geotechnical Engineer and/or the owner's representative. 18. Demolition/Construction Waste — Site is required to provide containment for waste prior to and during demolition/construction. Solid

waste roll off boxes and/or metal dumpsters shall be supplied by City or City permitted contractor(s) only. 19. Irrigation System—Potable water supply must be protected by either an atmospheric or pressure vacuum breaker, or testable double check valve assembly, and installed as per City Ordinances. 20. Fire Sprinkler System-Potable water supply must be protected by testable double check valve assembly, and installed per City

21. Potable Water Protection— All devices, appurtenances, appliances and apparatus intended o serve some special function and that connects to the water supply system, shall be provided with protection against backflow and contamination of the water supply system. 22. Contractor shall be responsible for the containment and proper disposal of all liquid and solid waste associated with this project. The contractor shall use all means necessary to prevent the occurrence of windblown litter from the project site. 23. 750-gallon grease trap requires verification and approval by City's control authority. Submittals of plumbing plans to City representative (Gregory Cox) are required prior to installation for approval.

Houston, Texas

(713) 266-3304 Zoning: C-Commercial Existing Use: Vacant Proposed Use: Hotel Setbacks: Per City of Bryan Ordinances 9. Site Area: 2.30 acres 10. Water Demands: Min.=0 gpm, Avg.=7.5 gpm, Peak=30 gpm

11. Sanitary Demands: Min.=0 gpd, Avg.=10,800 gpd,

Peak=43,200 gpd This property is not located within A 100-year floodplain per FEMA's Flood Insurance Rate Map panel 48041c0215f Effective

## PARKING REQUIREMENTS:

Date: April 2, 2014.

PARKING REQUIRED-1 REQUIRED SPACE PER ROOM 82 ROOMS X 1 SPACE/ROOM = TOTAL 82 REQUIRED SPACES

## PARKING PROVIDED - 95 PARKS AND 4-HANDICAP SPACES Handicap Parking:

Per Table 2 Section 4.1.2 of TAS for 76-100 needs 4 Space(s)

SQUARE FOOTAGE
GROSS SQUARE FOOTAGE: 44,872 SF

TOTAL PARKING PROVIDED - 99 PARKS (4 VAN ACCESSIBLE HANDICAP SPACES)

FIRE LANE SIGN

00 hp Ya

APRIL, 2015 Designed by: VJMB Drawn By: KB,JUJ Checked By: VJBM

T.979.260.6963

F.979.260.3564

3204 EARL RUDDER FWY

COLLEGE STATION, TX 7784

PLAN & DESIGN SPECIALISTS !

CMIL ENGINEERING + HYDRAULICS


HYDROLOGY \* UTILITIES \* STREETS

SITE PLANS + SUBDIVISIONS

VERONICA J.B. MORGAN 77689

CITY OF BRYAN

SITE <u>.</u>59

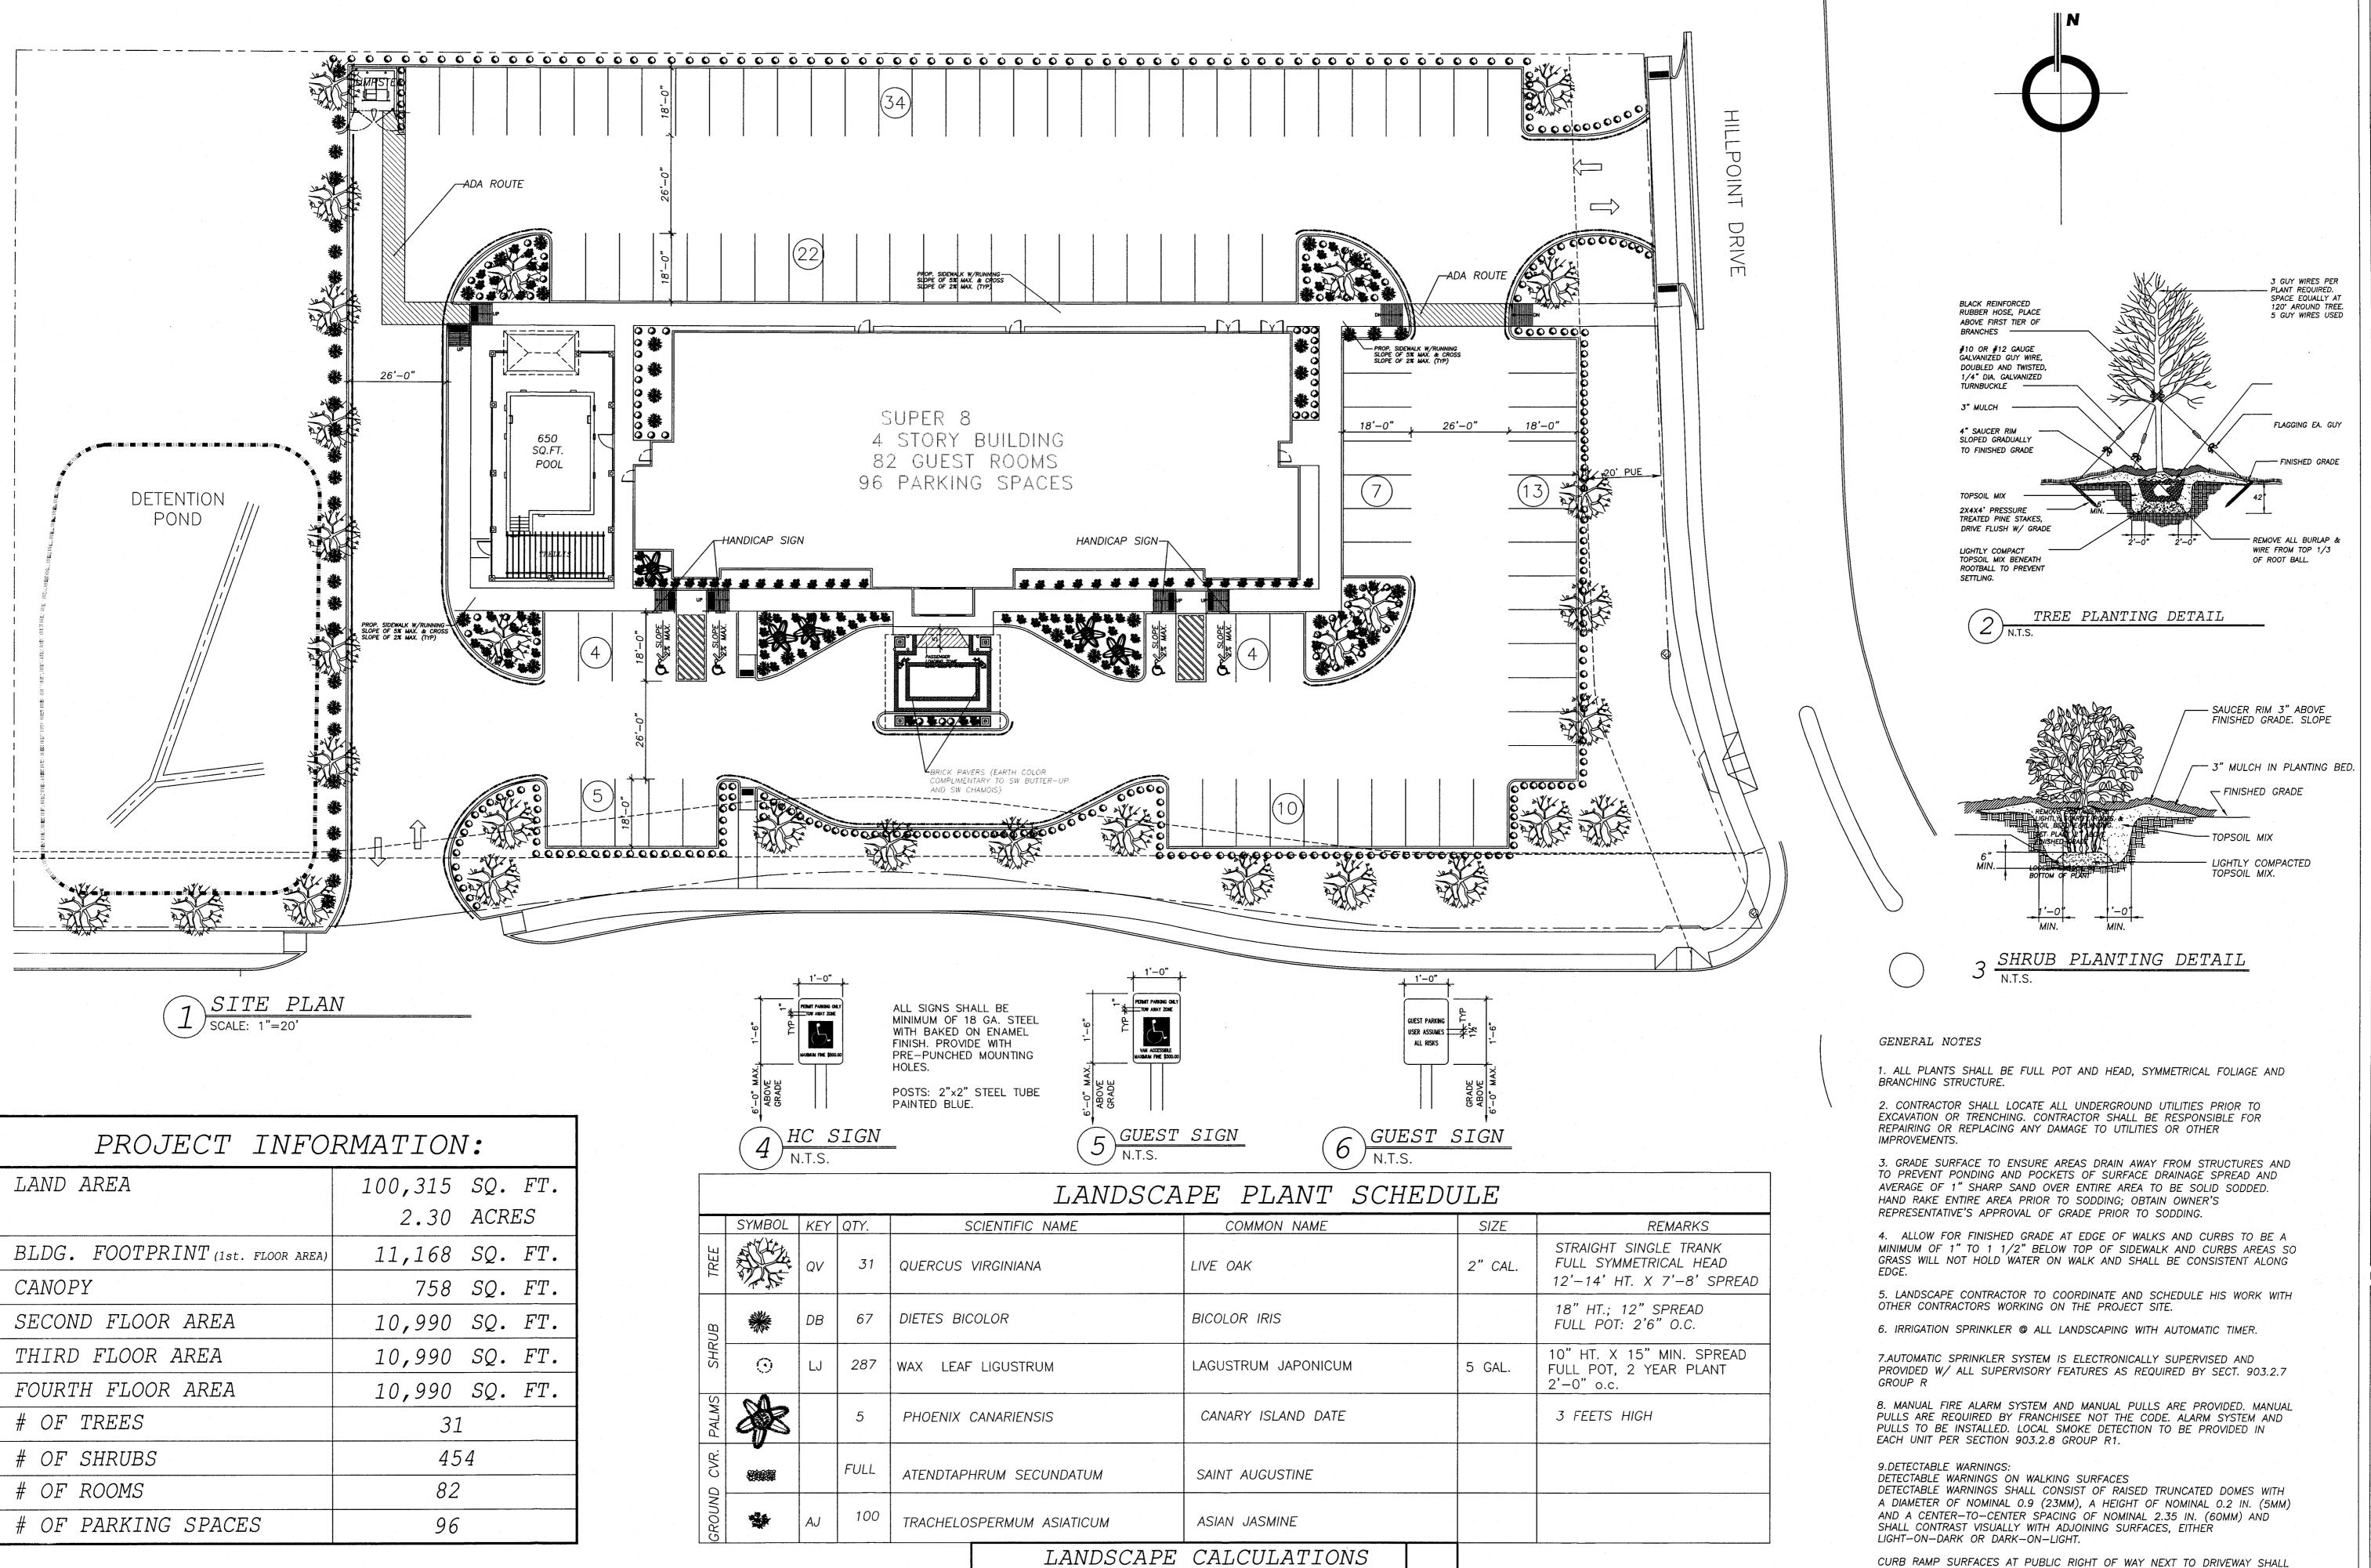

LAND AREA

IMPERVIOUS AREA


100,315 SQ. FT.

2.30 ACRES

65,250 SQ. FT. 65%

ASSOCIATES ARCHITECTS 800 W. SAM HOUSTON PKWY S. SUITE 123 HOUSTON, TX. 77042

> PH.(713)2663304 FAX.(713)2663305 EMAIL: drarchitects@sbcglobal.net

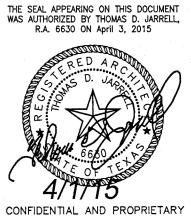

T

LANDSCAPE SITE PLAN

SHEET TITLE 1" = 20'-0"

SCALE

PROJECT NUMBER 4/3/2015

**C03.0** 

HAVE TRUNCATED DOMES AS PER SECTION 4.29.2

10. ALL GROUND EQUIPMENT SUCH AS GAS, WATER OR ELECTRICAL METERS

OR BOXES, HVAC UNITS, LP TANKS, ETC. TO BE SCREENED BY LANDSCAPE.

SHEET NUMBER